




NORTH ELEVATION
SCALE 1/8" = 1'-0"

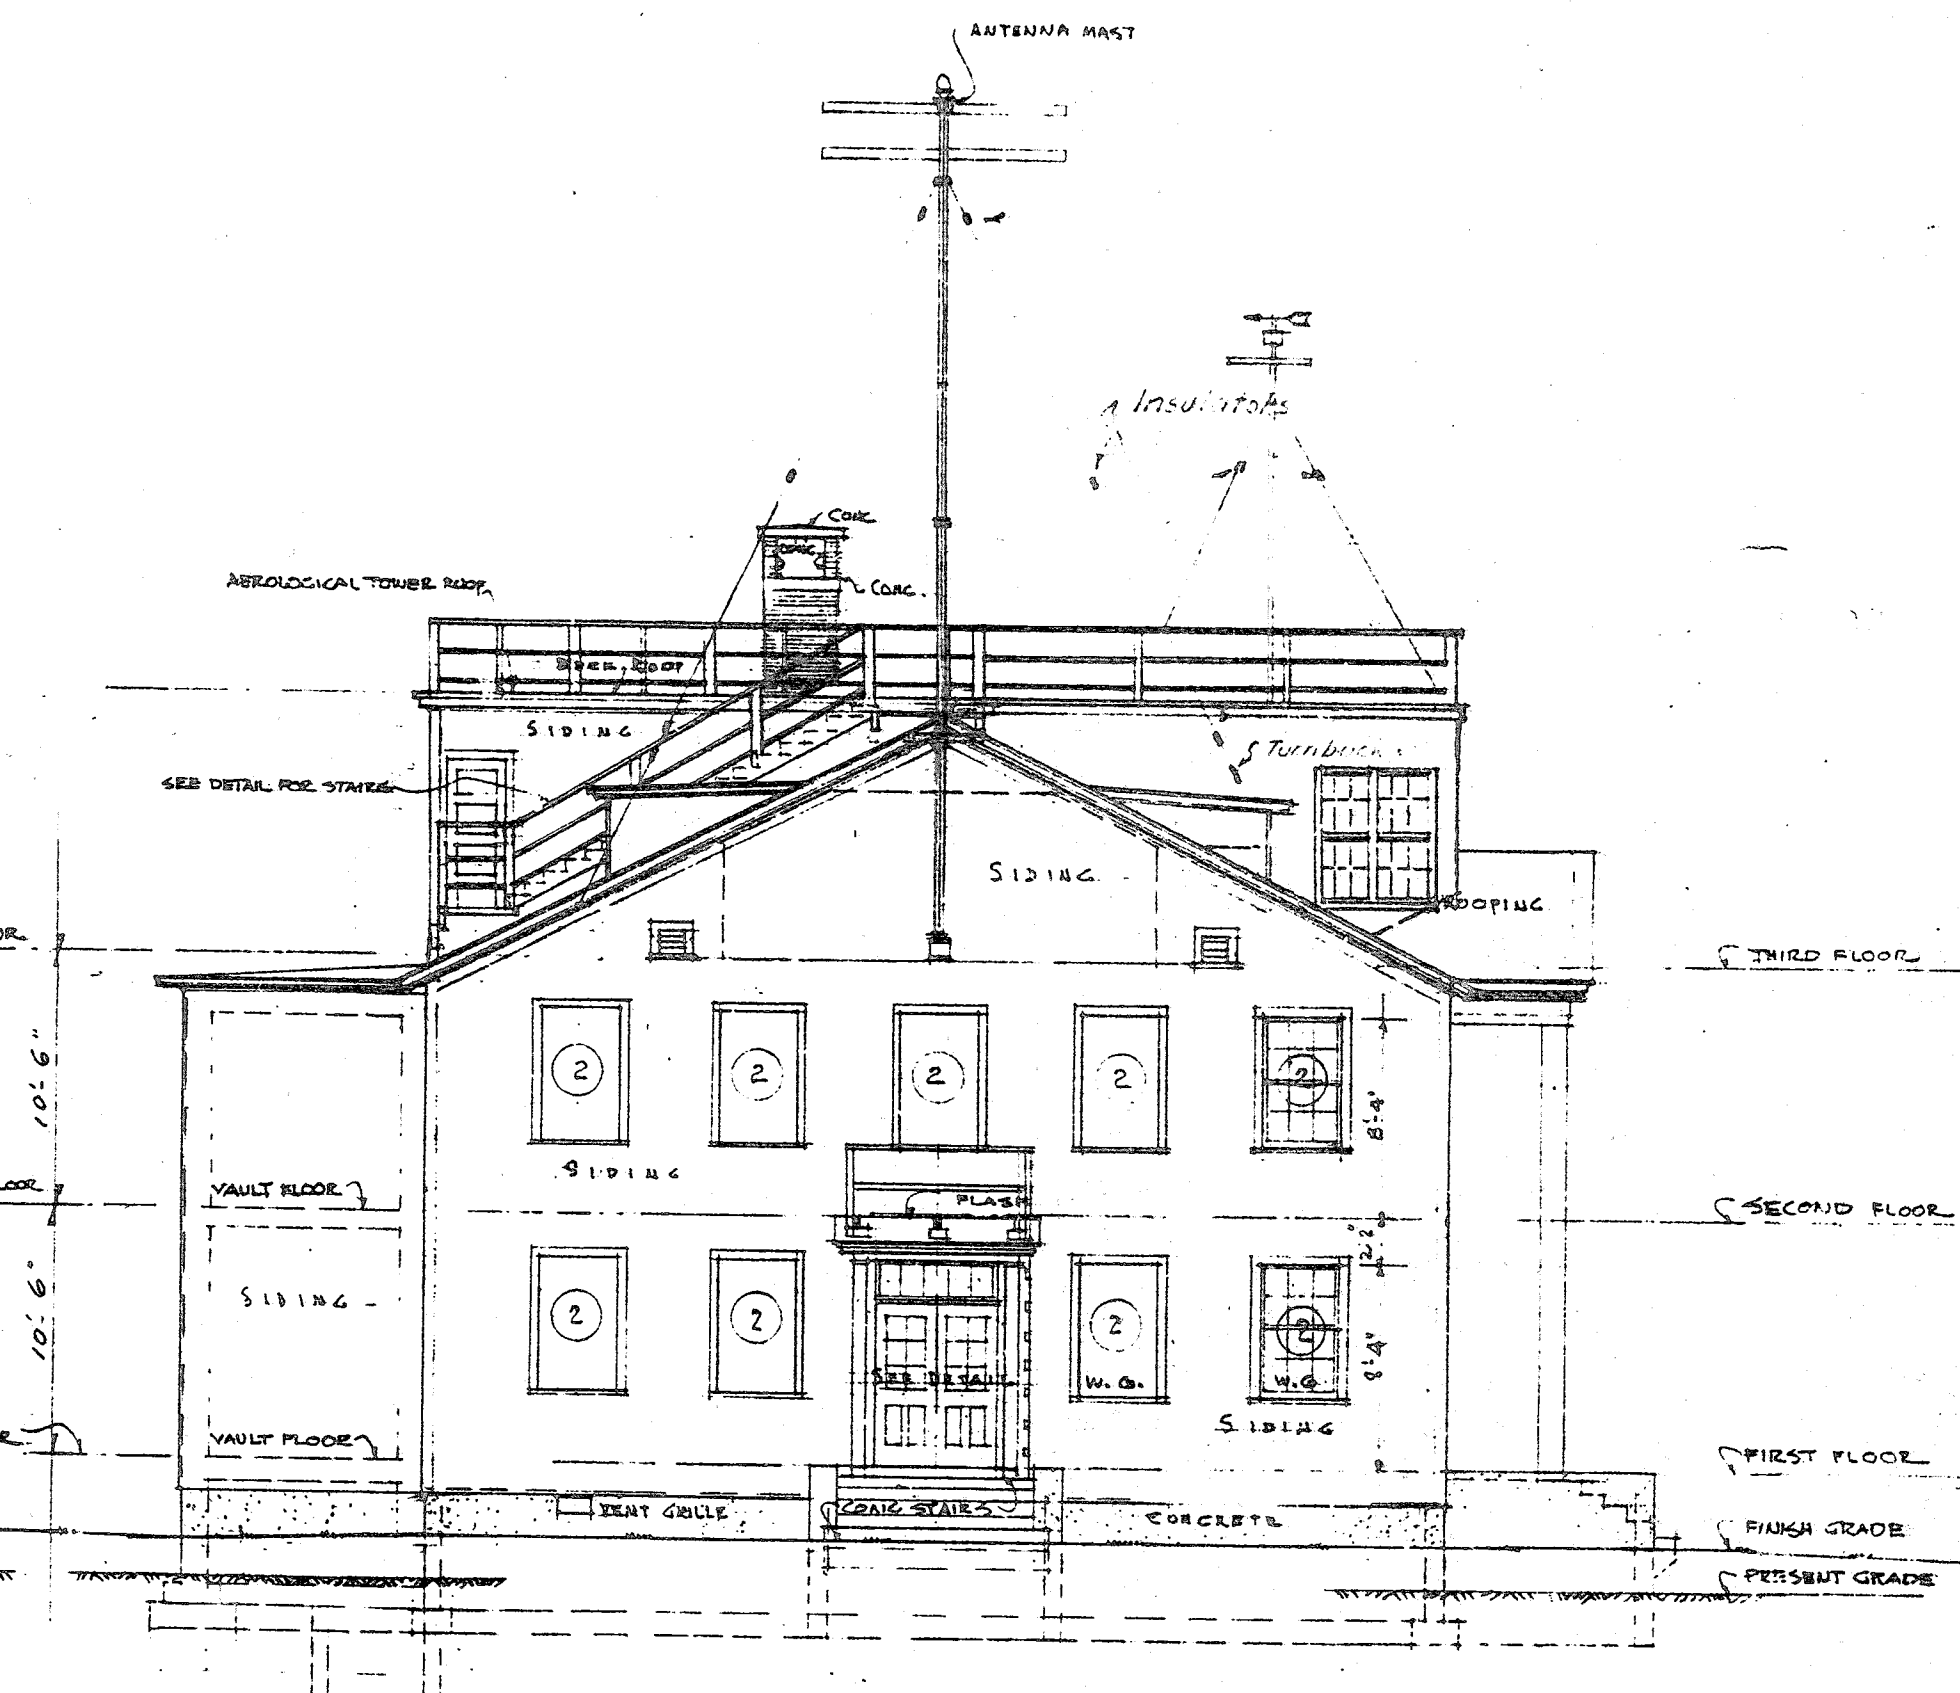

EAST ELEVATION
SCALE 1/8" = 1'-0"

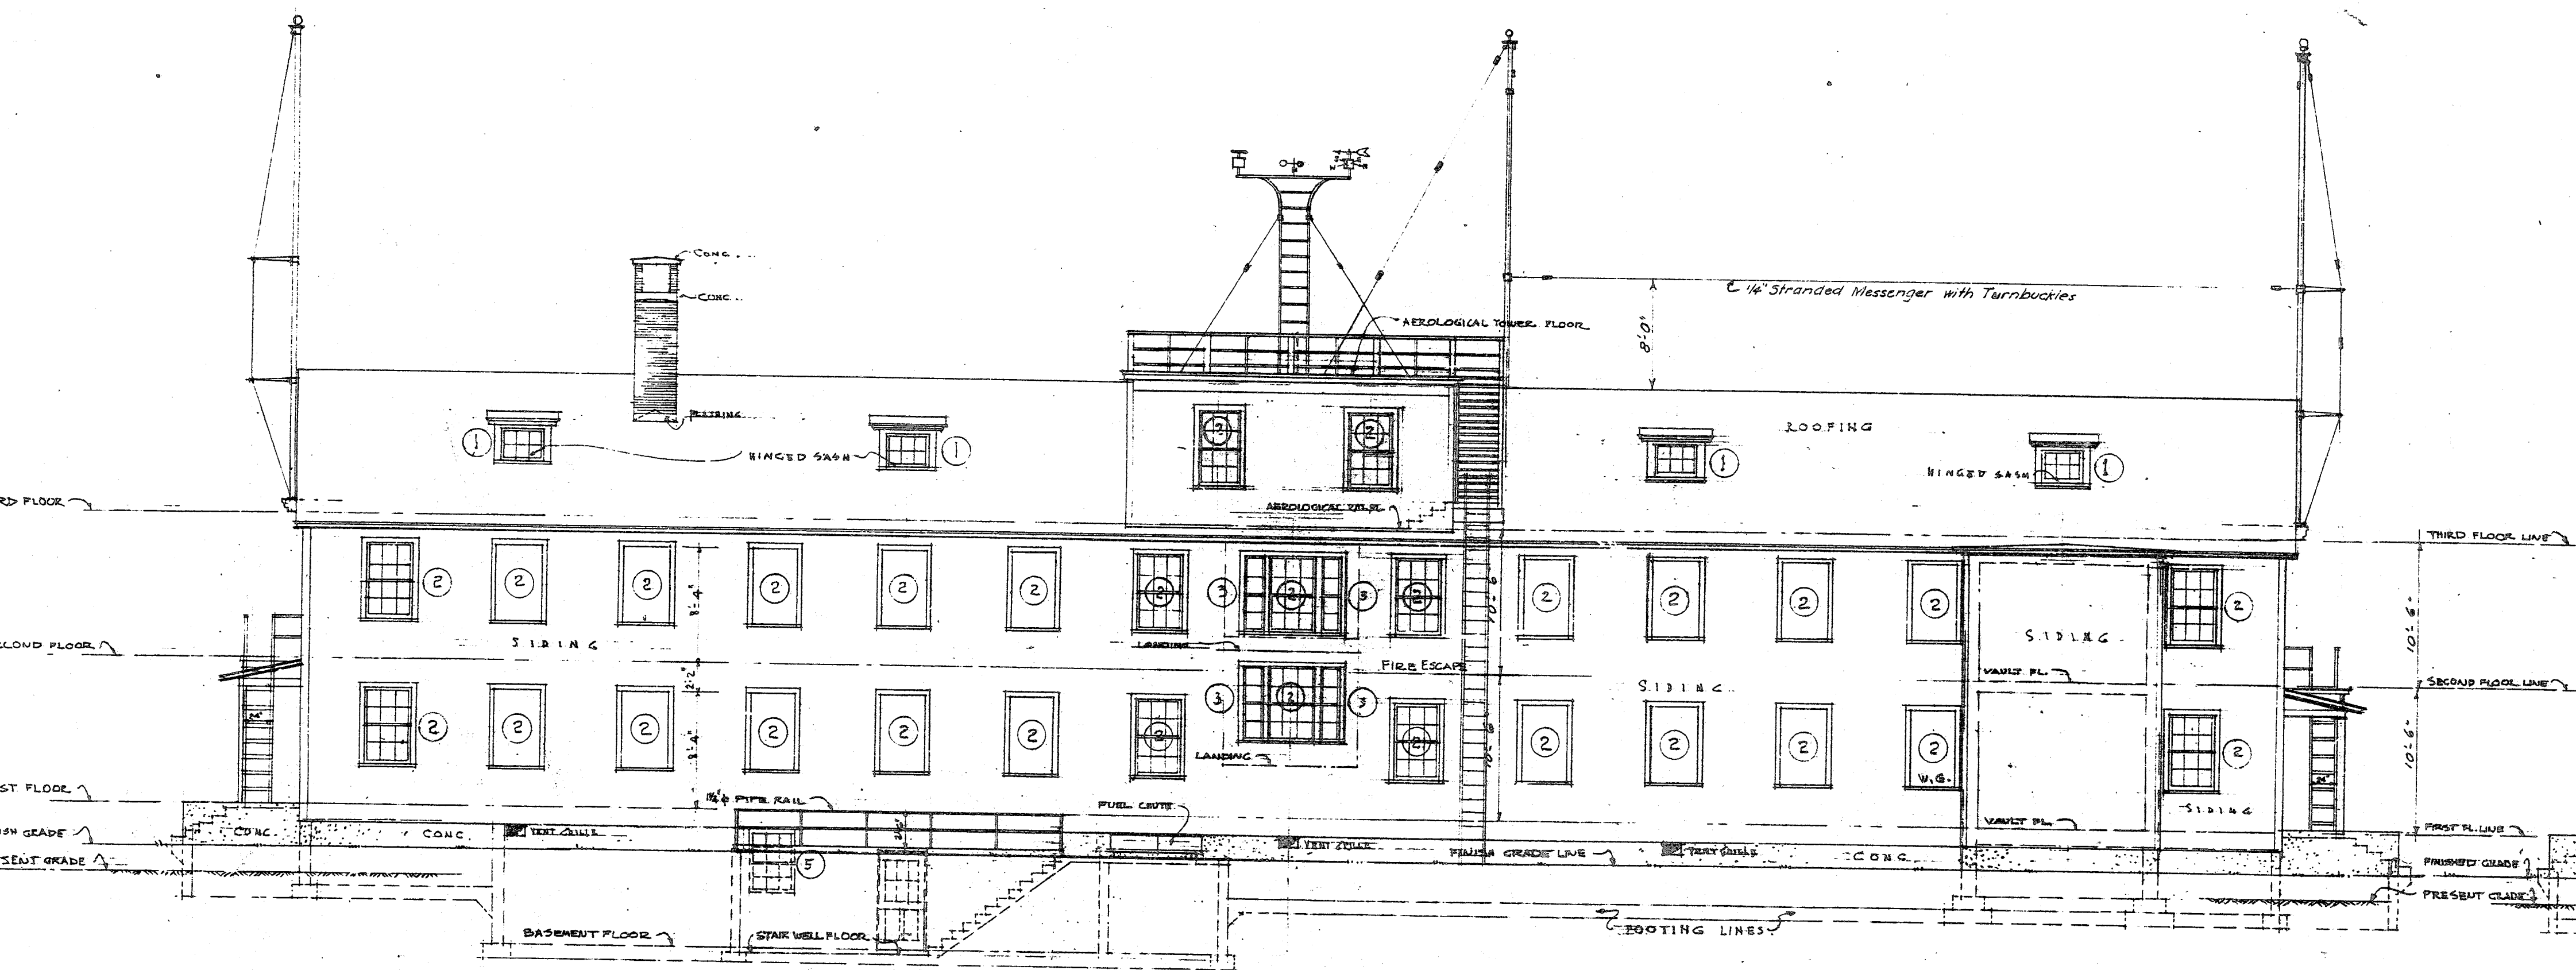


SOUTH ELEVATION
SCALE 1/8" = 1'-0"

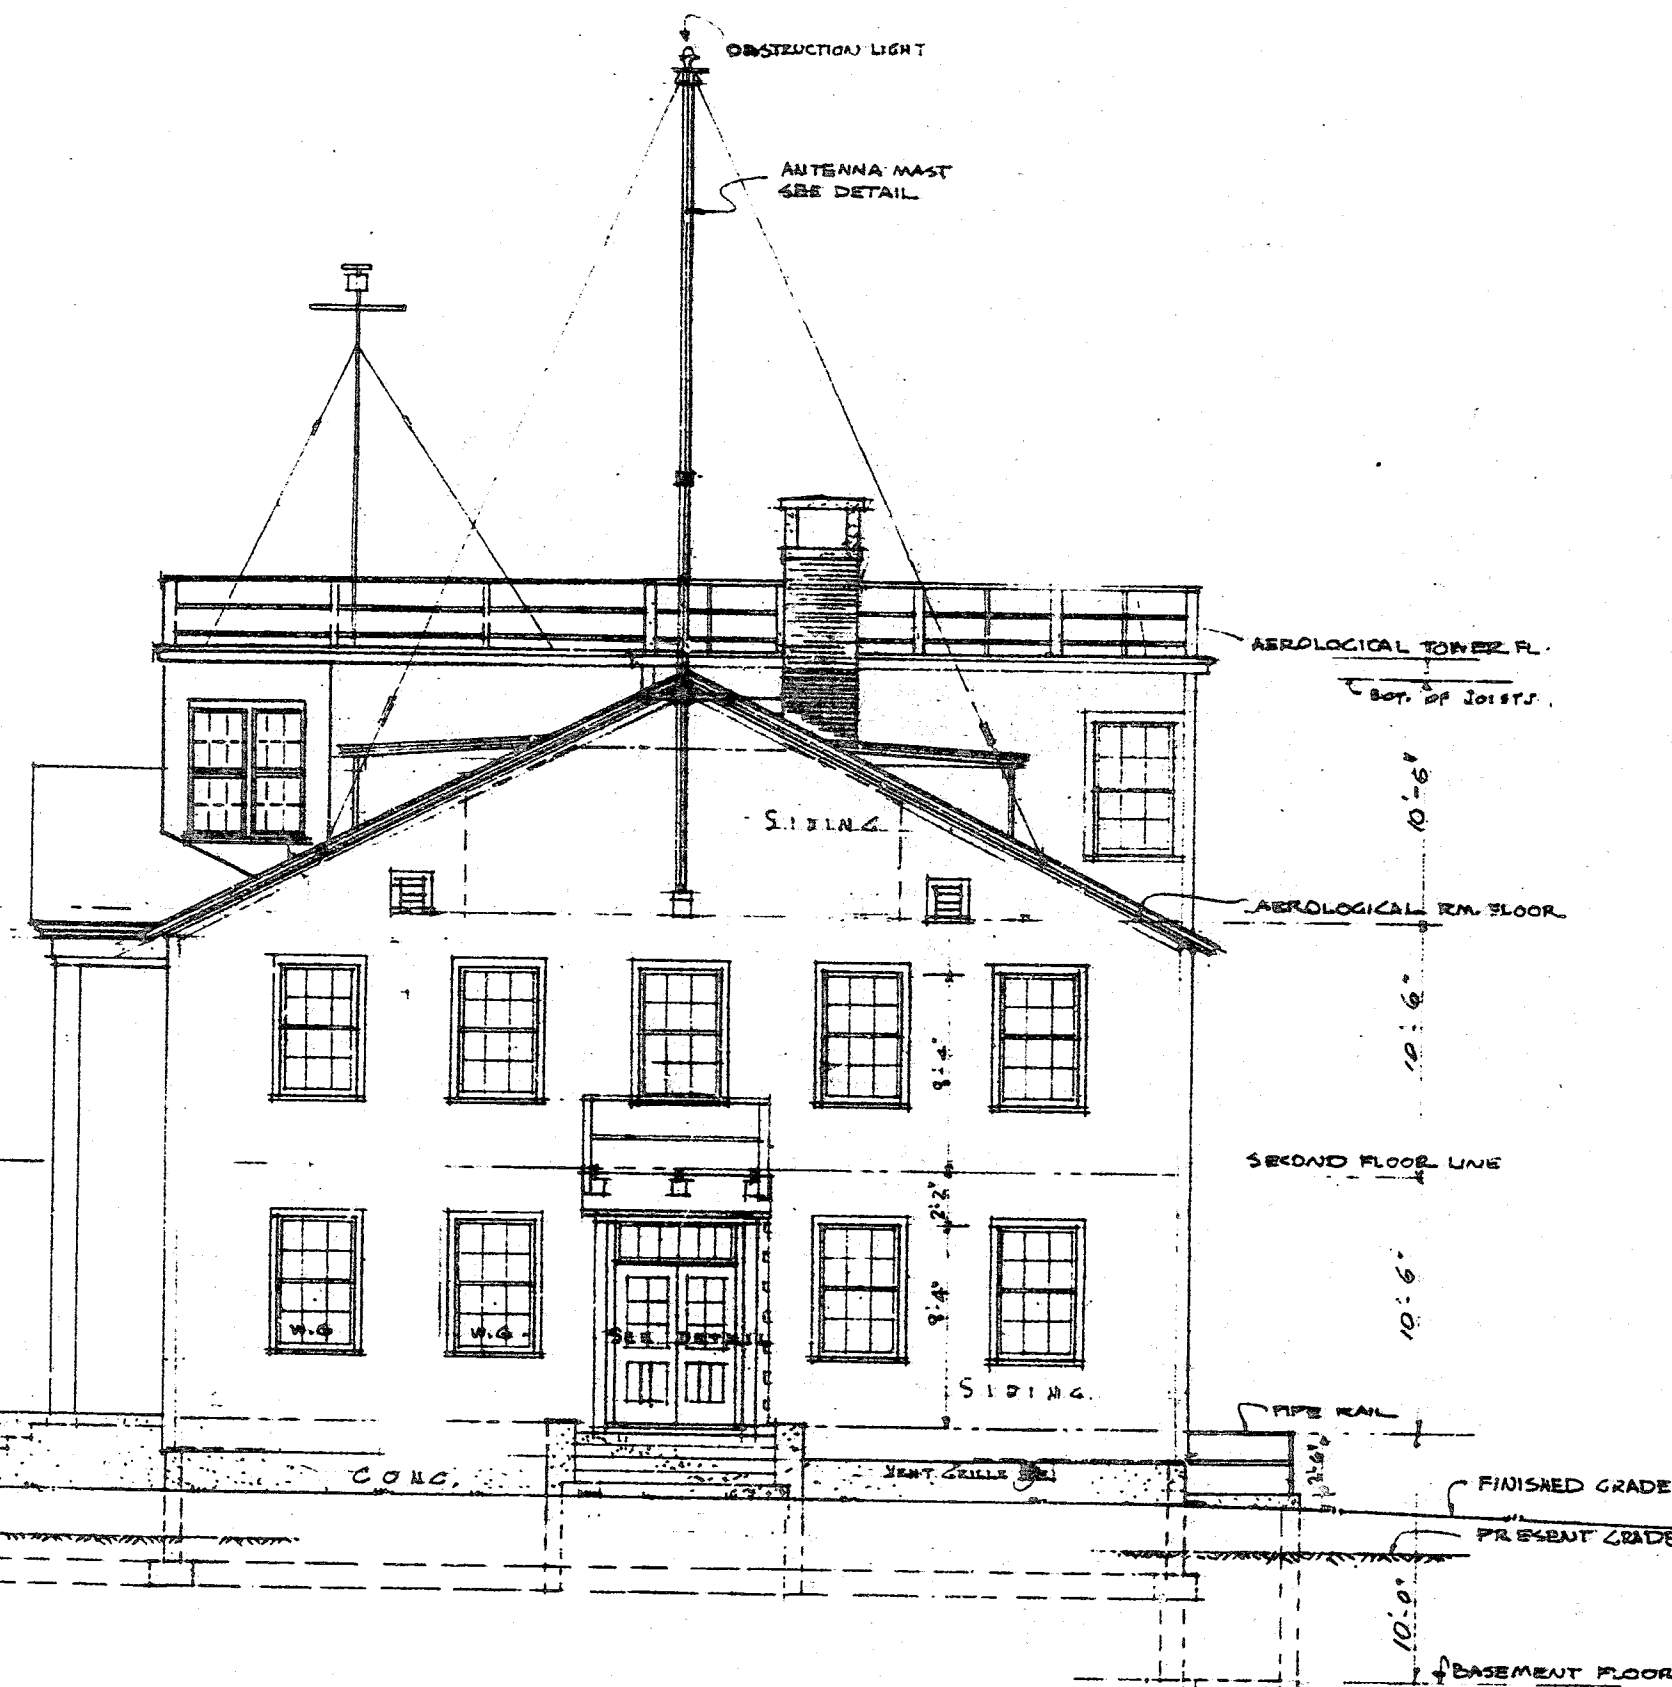

WEST ELEVATION
SCALE 1/8" = 1'-0"

WINDOW SCHEDULE

- 1 2'-5" x 3'-0" IN-SWING
 - 2 2'-4" x 5'-6" DOUBLE RUN
 - 3 1'-4" x 5'-6"
 - 4 1'-4" x 4'-2" OUT-SWING
 - 5 2'-6" x 4'-6" DOUBLE RUN
- W.G. WINDOW GUARD. SEE SOUND DWG. 256

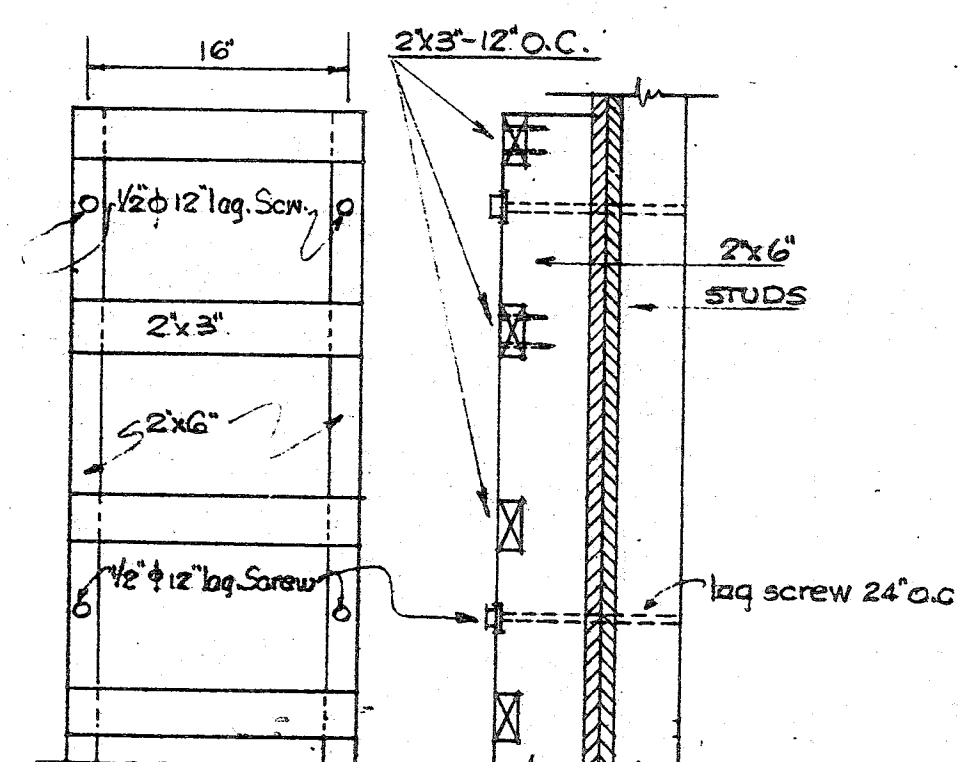

FIRE ESCAPE DET.
Scale 1" = 1'-0"

312,368

REVISION	BY	DATE	BRIEF	APP'D.
5				
4				
3				
2	FEH	6-30-43	THIRD FLOOR - MASTS & LADDERS REVISED	
1	JRR	10-2-42	Added mast & Revised mast at East End of Bldg.	
<div> <div> ENGINEERS CONTRACT NO. 5614 CONSTRUCTION CONTRACT NO. 5424 </div> <div> DRAWN BY W.W.H. TRACED BY CHECKED BY W.L.S. O.K. G.H.I. APPROVED DATE 11/10/43 </div> </div> <div> <div> JOHN W. CUNNINGHAM & ASSOCIATES ENGINEER ARCHITECT U.S. NAVAL AIR STATION (LTA) TILLAMOOK, OREGON ADMINISTRATION BLDG. ELEVATIONS SCALE 1/8" = 1'-0" APPROVED 11/10/43 Y.E.D. DRAWING NO. </div> </div>				